


Gas-Fired Tempered Make-Up Air Unit / DX

Model:

TK2-DX-3PH-FF

3-Phase, 230V, 3.00 HP, Belt driven with Motorized Damper and 15" Blower. MAX 3800 CFM's

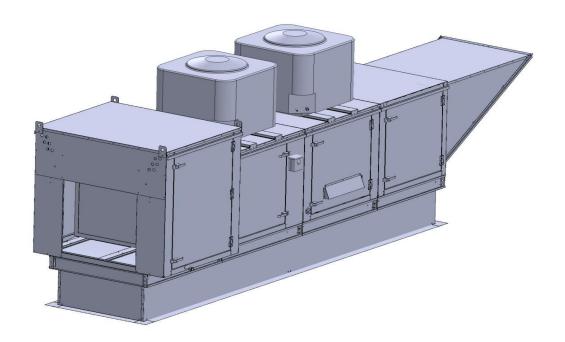

Tel: (440) 365-4567

Fax: (440) 365-2100

www.naksinc.com







TK2-500 Direct Fired MPU (1694 lbs./134 curb)

Supply Motor:

Model DTP0034, 3.000 HP, 3 Phase, 230 V, 60Hz, 8.6 FLA, ODP, Premium (E-Plus3) Eff.

Supply Motor Pulleys:

Part Type	<u>Qt</u> y	Browning #	Turns Out
Belt	2	BX50	
Blower Pulley	1	2BK60H	
Bushing	1	H-1	
Motor Pulley	1	2VP42 x 1 1/8	4.0

Burner:

Min Output BTU: 18,000 BTU/Hr Max Output BTU: 550,000 BTU/Hr

Size: 12" long Gas Type: Natural

Supply Performance:

Volume: 3800 cfm Volume Range: 2700-3800 cfm

RPM: 1037 TS: 4072 ft/min SP: 0.991" w.g.

0.500" Ext. + 0.060" Int. + 0.431" Opt.

BHP: 2.513

Heating Schedule:

Altitude: 0'

Winter Entering Air Dry Bulb Temp: 0°F

Temp Rise: 100°F Output BTU: 410400 Input BTU: 446087

BTUs BASED OFF STANDARD AIR DENSITY

Cooling Schedule:

DX Coil Entering Dry Bulb Temperature: 90°F DX Coil Entering Wet Bulb Temperature: 72°F DX Coil Leaving Dry Bulb Temperature: 76°F DX Coil Leaving Wet Bulb Temperature: 67°F

DX Coil Total Capacity: 69.1 MBH DX Coil Sensible Capacity: 56.6 MBH DX Coil Latent Capacity: 12.5 MBH

Temperature drop calculations are based on tested data.

Supply Installation Information:

Gas Inlet Pressure: 7 in. w.c. - 14 in. w.c. Insurance: No Insurance Requirement (ANSI)

Unit Main Input: 11.8 Amps MCA, 20 Amps MOP, 230 V, 14 AWG

Wire Min.

Condenser #1: 21.4 Amps MCA, 30 Amps MOP, 208-230, 12 AWG

Wire Min.

Condenser #1: 11.2 Amps MCA, 20 Amps MOP, 208-230, 14 AWG

Wire Min.

Supply Unit Voltage: 3 phs 230 V 60Hz

Construction Features

Housing constructed of heavy duty G90 galvanized steel • Forward curved centrifugal blower wheel • Vibration isolation • Adjustable drive assemblies • Adjustable motor mount • Ball bearing motors • Heavy duty, pre-lubricated bearings rated for 200,000 hours of operation • Static resistant belts • Service doors on both sides • Horizontal & down discharge • Large intake area ensures low pressure drop across unit • Spring loaded profile plates automatically adjust for any airflow - no manual setting required! • Weatherproof safety disconnect switch • Modular design provides design flexibility • Fully insulated casing

Blower:

15" forward curved, centrifugal blower. Pillow Block ball bearings. Galvanized finish. 1" x 27-1/8" Shaft. 2000-7500 CFM. 1800 max. RPM. Used in heated and non-heated supply fans.

Temp Control:

RTC Solutions • 40-90°F Discharge Temp Control • Field Wired On/Off Start Command

Intake:

Sloped Filtered Intake for Size #2 Modular Heater. 26.813" Wide X 53.625" Long X 31.313" High. Includes 2" MV EZ Kleen Metal Mesh Filters.

Filters:

3x MV EZ Kleen Metal Mesh Filter. 20"x 25"x 2" Used for heater and supply fan intakes. (3416)

Curb & Supports:

RAIL - 6" Width X 31" Length X 20" Height ROOF CURB - 31" Wide X 79" Long X 20" High, Insulated. For the # 2 Modular Heater.

Selected Options:

- Motorized Back Draft Damper 22.75" X 24" for Size 2 Standard & Modular Heater Units w/Extended Shaft, Standard Galvanized Construction, 3/4" Rear Flange, Low Leakage, LF120S Actuator Included
- Low Fire Start. Allows the burner circuit to energize when the modulation control is in a low fire position.
- Gas Pressure Gauge, 0-35", 2.5" Diameter, 1/4" Thread Size
- Gas Pressure Gauge, -5 to +15 Inches Wc., 2.5" Diameter, 1/4" Thread Size
- DX Cooling Intake Air Thermostat and Relays Mounted in Unit Set Point For Thermostat Should Be 85°F.
- 7.5 Ton, Dual Circuit (2.5/5) Modular Packaged Cooling Option for Size 2 Modular Packaged Unit. Includes Condenser, DX Coil, Filter/Dryer Kit, Thermal Expansion Valve, R410A Refrigerant, and Refrigerant Piping. (2,700 to 4,500 cfm) NOT BUILT WITH OPPOSITE SIDE CONTROLS OR OPPOSITE AIRFLOW DIRECTION.
 CONDENSERS REQUIRE SEPARATE 208V, 3 PHASE POWER SUPPLY UNLESS ORDERED WITH SINGLE POINT CONNECTION.
 Coil = 3EZ1101C
- Downturn Plenum for Size 2 Cooling Coil Module Required for Down Discharge Cooling Coil Applications

TK2 DIRECT FIRED HEATER WITH DX COOLING

- 1. DIRECT GAS FIRED HEATED MAKE UP AIR UNIT WITH 15" BLOWER
- 2. INTAKE HOOD WITH EZ FILTERS
- 3. DOWN DISCHARGE AIR FLOW RIGHT -> LEFT
- 4. MOTORIZED BACK DRAFT DAMPER 22.75" X 24" FOR SIZE 2 STANDARD & MODULAR HEATER UNITS W/EXTENDED SHAFT, STANDARD GALVANIZED


- CONSTRUCTION, 3/4" REAR FLANGE, LOW LEAKAGE, LF120S ACTUATOR INCLUDED

 5. LOW FIRE START, ALLOWS THE BURNER CIRCUIT TO ENERGIZE WHEN THE MODULATION CONTROL IS IN A LOW FIRE POSITION.

 6. GAS PRESSURE GAUGE, 0-35", 2.5" DIAMETER, 1/4" THREAD SIZE
- 7. GAS PRESSURE GAUGE, -5 TO +15 INCHES WC., 2.5" DIAMETER, 1/4" THREAD SIZE
- 8. FULL CRATING FOR COMMERCIAL HEATERS FOR SHIPPING.
- 9. DX COOLING INTAKE AIR THERMOSTAT AND RELAYS MOUNTED IN UNIT SET POINT FOR THERMOSTAT SHOULD BE 85°F.

 10. 7.5 TON, DUAL CIRCUIT (2.5/5) MODULAR PACKAGED COOLING OPTION FOR SIZE 2 MODULAR PACKAGED UNIT. INCLUDES CONDENSER, DX COIL,
- FILTER/DRYER KIT, HARD START KIT, THERMAL EXPANSION VALVE, R410A REFRIGERANT, AND REFRIGERANT PIPING.
- 11. DOWNTURN PLENUM FOR SIZE 2 COOLING COIL MODULE REQUIRED FOR DOWN DISCHARGE COOLING COIL APPLICATIONS
- 12. PROFILE PLATE CONFIGURATION FOR SIZE 2 DIRECT FIRED UNIT FOR LOW CFM APPLICATIONS.

NOTE: SUPPLY DUCT MUST BE INSTALLED TO MEET SMACNA STANDARDS. A MINIMUM STRAIGHT DUCT LENGTH MUST BE MAINTAINED DOWNSTREAM OF UNIT DISCHARGE UNLESS OTHERWISE SPECIFIED. DO NOT RELY ON UNIT TO SUPPORT DUCT IN ANY WAY, FAILURE TO PROPERLY SIZE DUCTWORK MAY CAUSE SYSTEM EFFECTS AND REDUCE PERFORMANCE OF THE EQUIPMENT.

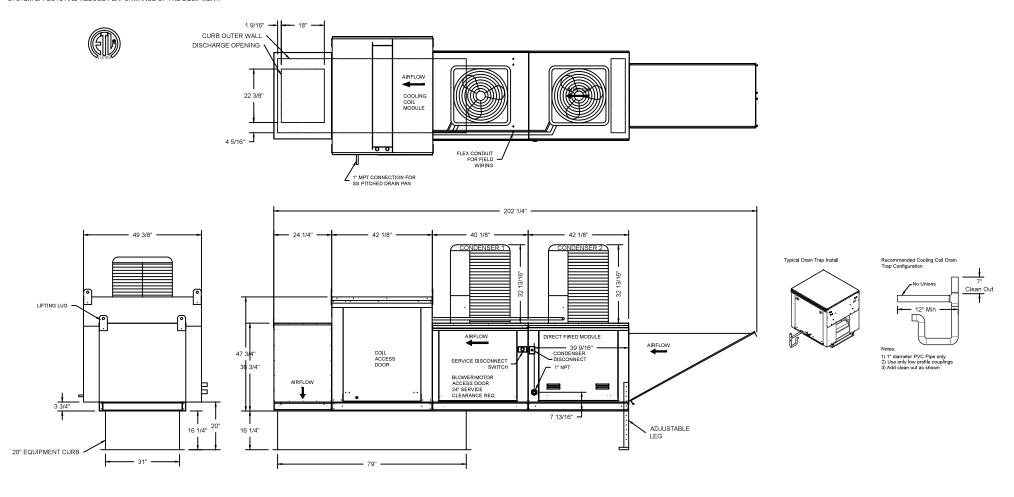








JOB	
LOCATION	
DATE 8/1/18	JOB #
DWG #	DRAWN BY
REV.	SCALE

3800 CFM, 0.991 SP @ 1037 RPM and 2.513 BHP at 0 feet and 100 deg F \ast Please note that these curves were adjusted for job specific temperature and altitude.

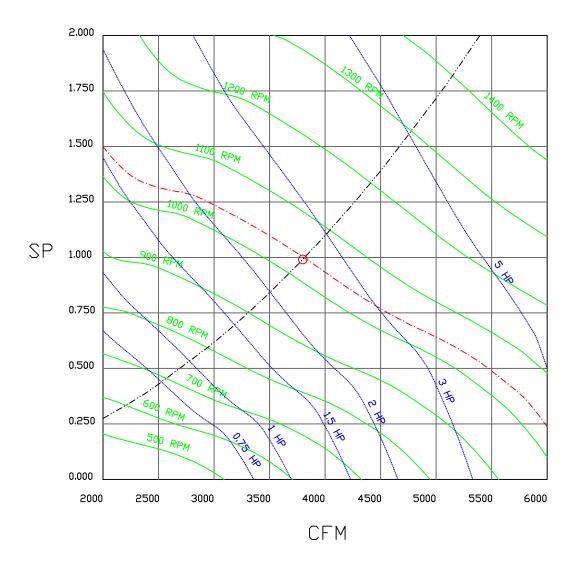





JOB	
LOCATION	
DATE 8/27/2018	JOB #
DWG #	DRAWN BY
REV.	SCALE 3/8" = 1'-0"

